CITY OF MUSKEGON

WALTON AVENUE & MARSH ST FROM EMERALD ST TO 105' NW OF WOOD ST.

INDEX TO SHEETS

SHEET DESCRIPTION

1 — TITLE SHEET

CROSS SECTION AND DETAIL SHEET

3 ------STA -0+04 (P.O.B.) TO STA 4+00 ROAD PLAN AND PROFILE

STANDARD PLANS

R-1-G DRAINAGE STRUCTURES

R-28-J SIDEWALK RAMP AND DETECTABLE WARNING DETAILS
R-29-I DRIVEWAY OPENINGS & APPROACHES, AND CONCRETE SIDEWALKS

R-30-G CONCRETE CURB AND CONCRETE CURB & GUTTER

R-83-C UTILITY TRENCHES

R-96-E SOIL EROSION & SEDIMENTATION CONTROL MEASURES

R-7-F COVER B


R-15-F COVER K

NOTE: STANDARD PLANS INCLUDED IN PROPOSAL

TRAFFIC/SAFETY STANDARD PLANS

WZD-100-A GROUND DRIVEN SIGN SUPPORTS FOR TEMPORARY SIGNS WZD-125-E TEMPORARY TRAFFIC CONTROL DEVICES

STANDARD PLANS INCLUDED IN PROPOSAL

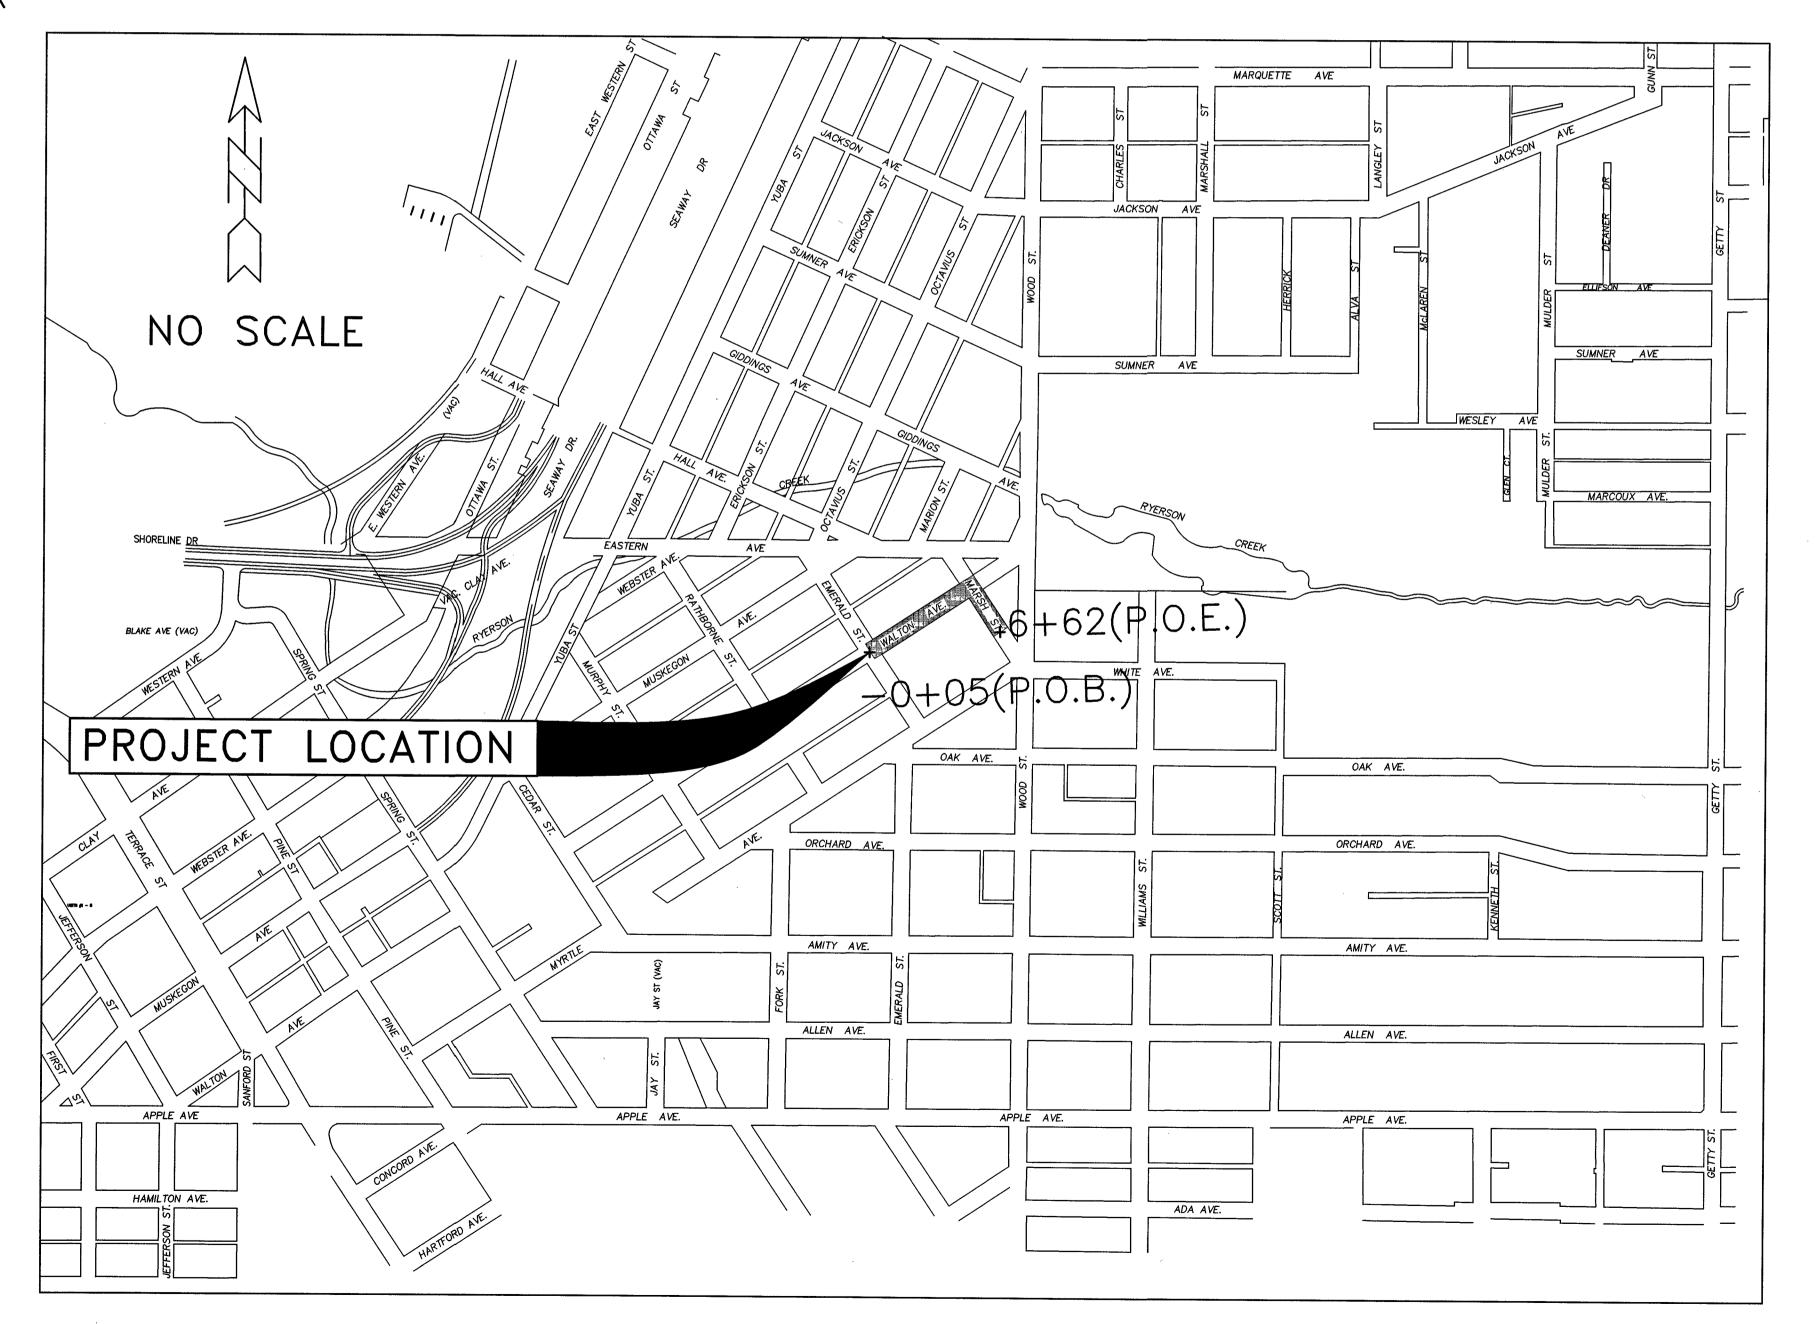



UTILITIES

ELECTRIC

CONSUMERS ENERGY — MICHELLE PETERSON 700 E. STERNBERG RD. NORTON SHORES, MI 49441 (231) 332-2621

TELEPHONE

FRONTIER COMM. — DAVID B. FLERMOEN 860 TERRACE STREET MUSKEGON, MI 49440 (231) 727—1319

GAS

DTE ENERGY- VINCE DUCA 2359 OLTHOFF DRIVE MUSKEGON, MI 49444 (231) 777-4034

CABLE

COMCAST — JIM ZAWACKI 3500 PATTERSON AVE SE GRAND RAPIDS, MI 49512 (616) 575—0501

WATER & SEWER

CITY OF MUSKEGON DPW – DAVE BAKER, MIKE HANNAN 1350 E KEATING AVENUE MUSKEGON, MI 49442 (231) 724-4100

NOTE:

THE IMPROVEMENTS COVERED BY THESE PLANS SHALL BE
DONE IN ACCORDANCE WITH THE MICHIGAN DEPARTMENT OF
TRANSPORTATION 2012 STANDARD SPECIFICATIONS FOR
CONSTRUCTION AND THE 2011 MICHIGAN MANUAL OF UNIFORM
TRAFFIC CONTROL DEVICES. THESE IMPROVEMENTS HAVE
BEEN DESIGNED IN ACCORDANCE WITH THE 2004 AASHTO
GUIDELINES.


CITY OF MUSKEGON
OFFICE OF THE CITY ENGINEER


DRAWN F. PEASE FEB 19 REVISION
CHECKED

APPROVED


WALTON AVE, MARSH ST.,
EMERALD TO WOOD
SURVEY F.PEASE NOV 19 H — 91841
PROJECT NO
SCALE NO SCALE SHEET NO 1 OF 4

WALTON AVENUE & MARSH ST CROSS SECTION AND DETAIL SHEET

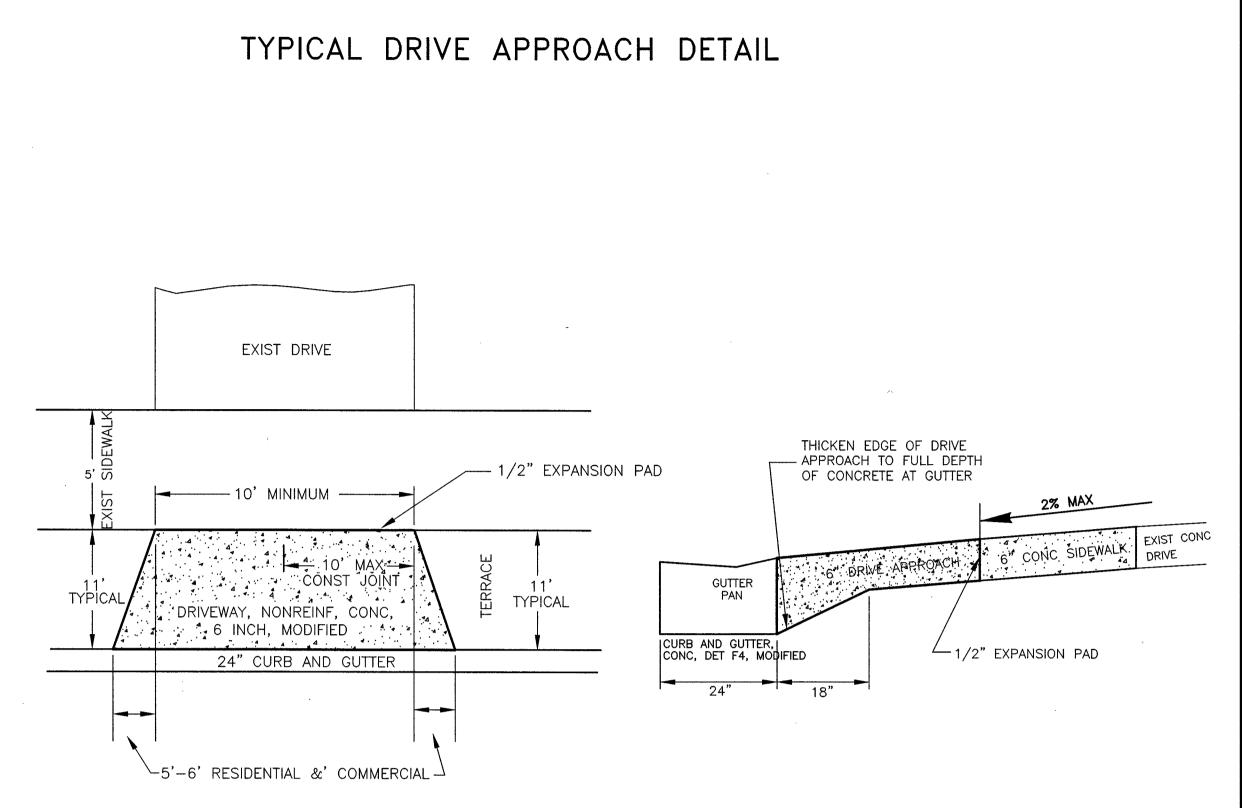

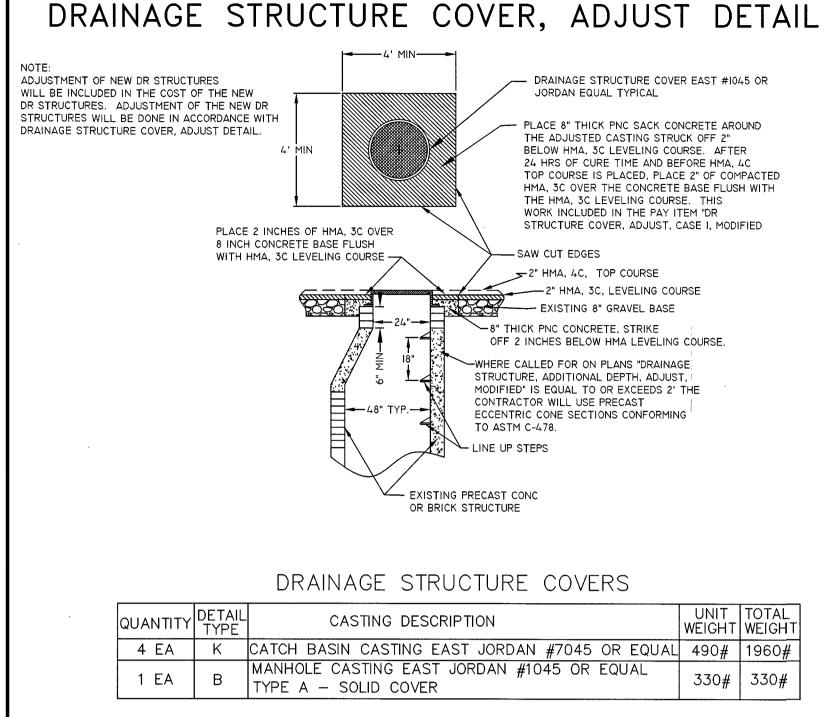


NO SCALE

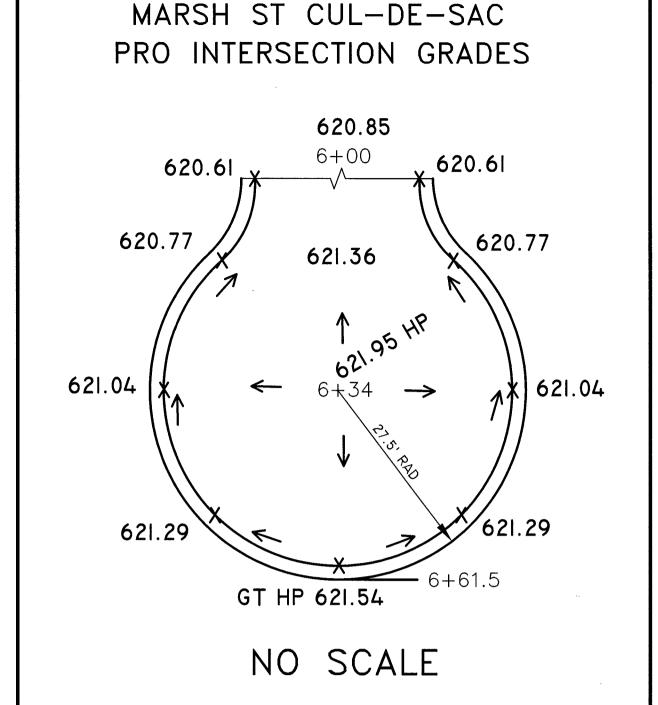

SUMMARY OF PAVEMENT CORING										
CORE #	STATIO	N #	HMA THICKNESS	GRAVEL THICKNESS	SOIL TYPE TO 10' BELOW PAVT					
1	6+45	LT	NA	8.5"	SAND: COMPACT BROWN FINE					
2	1+84	RT	NA	5"	SAND: COMPACT BROWN FINE					

NOTE: NO GROUND WATER ENCOUNTERED

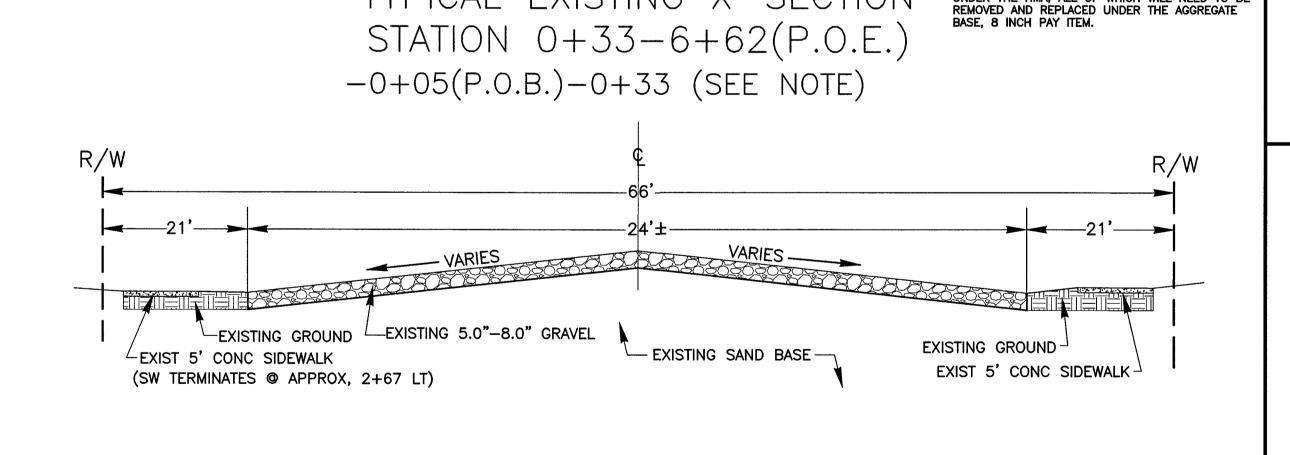



TYPICAL EXISTING X-SECTION

APPROXIMATELY 3" OF HMA FROM STA.

-0+05-0+33 UNDER THE PAVMT, REM, MODIFIED

ITEM. THERE IS APPROXIMATELY 6" OF GRAVEL

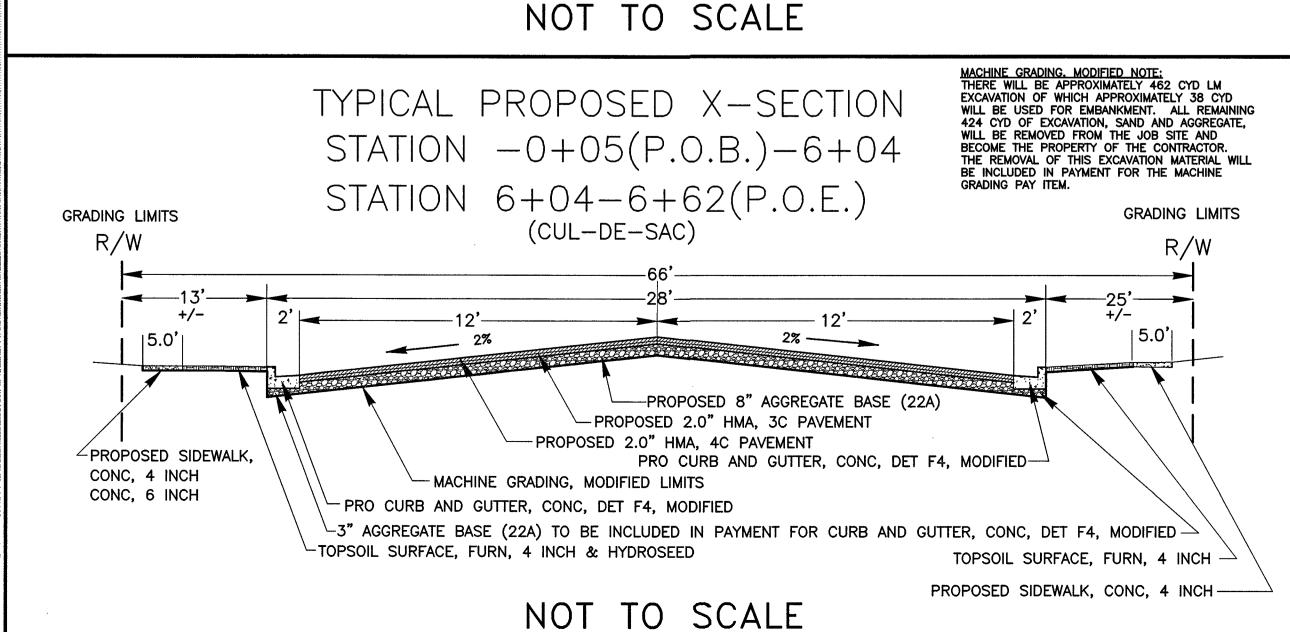


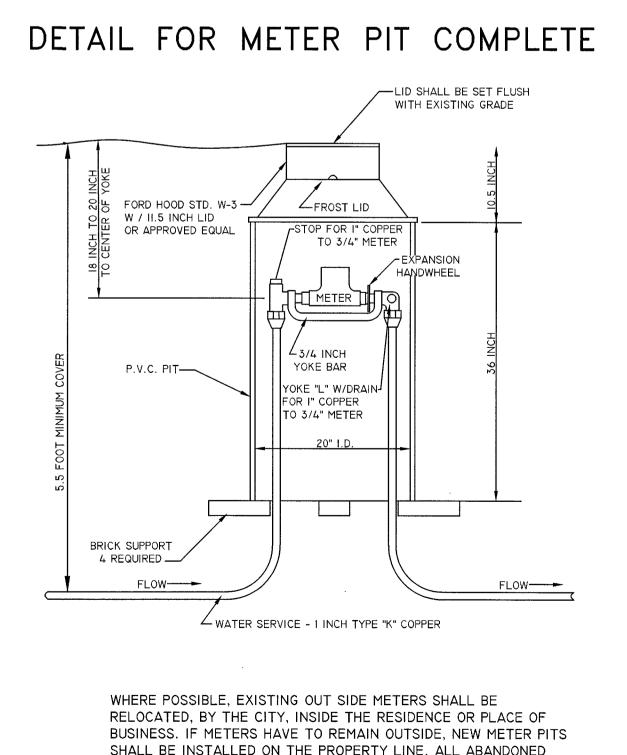

METER PITS SHALL BE REMOVED BY THE CONTRACTOR, THE

REMOVAL TO BE INCLUDED IN THE NEW WATER SERVICE.

NO SCALE

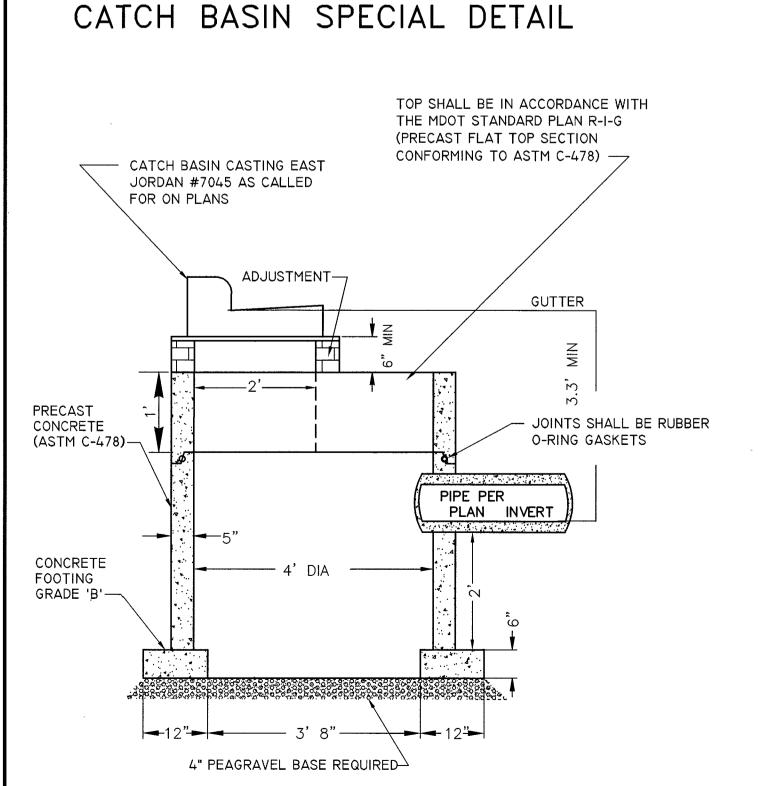

NO SCALE


Know what's below. CALL MISS DIG

GENERAL NOTES:


- 1. UPON REQUEST AND APPROVAL, THE CONTRACTOR MAY OBTAIN A WATER SUPPLY FROM THE CITY OF MUSKEGON FIRE HYDRANTS AT NO COST, PROVIDED THAT THEY FOLLOW THE CONDITIONS OF THE CITY WATER DEPARTMENT.
- 2. WHENEVER SMALL CASTINGS (STOP BOXES, METER PITS, MONITORING WELLS) ARE ENCOUNTERED WITHIN THE WORK AREA THEY SHALL BE ADJUSTED AT NO COST TO THE CITY. PAYMENT SHALL BE INCLUDED WITH THE LINE ITEM OF WORK BEING PERFORMED.
- 3. FOR PROTECTION OF UNDERGROUND UTILITIES. THE CONTRACTOR SHALL CALL MISS DIG, (811) 1-800-482-7171, A MINIMUM OF 3 WORKING DAYS EXCLUDING SATURDAYS, SUNDAYS, AND HOLIDAYS PRIOR TO EXCAVATING IN THE VICINITY OF ALL UTILITY LINES. ALL MISS DIG PARTICIPATING MEMBERS WILL THUS BE NOTIFIED, THIS DOES NOT RELIEVE THE CONTRACTOR THE RESPONSIBILITY OF NOTIFYING OWNERS WHO MAY NOT BE PART OF THE MISS DIG ALERT SYSTEM.
- 4. PUBLIC UTILITIES OF ALL TYPES HAVE BEEN SHOWN ON THE PLAN USING AVAILABLE INFORMATION. BUT ARE NOT GUARANTEED AS ACCURATE, OR THAT UTILITIES OTHER THAN THOSE SHOWN ARE NOT PRESENT. THE CONTRACTOR SHALL CALL MISS DIG 3 WORKING DAYS (EXCLUDING SAT., SUN., AND HOLIDAYS) BEFORE DIGGING (1-800-482-7171).
- 5. EXISTING TRAFFIC CONTROL SIGNS THAT NEED TO BE REMOVED TO ALLOW THE CONTRACTOR TO WORK WILL BE REMOVED BY THE CONTRACTOR AND STORED IN A SAFE PLACE TO AVOID DAMAGE. THE CONTRACTOR SHALL THEN REINSTALL THE SIGNS IN THEIR ORIGINAL LOCATION OR AS DIRECTED BY THE ENGINEER. REMOVAL AND REPLACEMENT OF THE SIGNS WILL BE INCLUDED IN THE ITEM OF MINOR TRAF DEVICES. SIGNS THAT ARE DAMAGED BY THE CONTRACTOR WILL BE REPLACED BY CITY FORCES, AND THE CONTRACTOR WILL PAY THE CITY FOR THE COST OF REPLACEMENT.
- 6. THE CONTRACTOR SHALL SAW CUT ALL MEETS RELATIVE TO SIDEWALK OR PAVEMENT CONSTRUCTION UNLESS WAIVED BY THE ENGINEER. PAYMENT FOR SAW CUTTING SHALL BE INCLUDED IN THE PAYMENT FOR THE PAY ITEMS SYD PAVT, REM, MODIFIED, CURB AND GUTTER, REM, HMA SURFACE, REM AND SIDEWALK, REM. NO ADDITIONAL PAYMENT WILL ALLOWED FOR SAW CUTTING.
- 7. IRRIGATION SYSTEMS AS MARKED OR STAKED DAMAGED THROUGH CARELESS WORK BY THE CONTRACTOR WILL BE REPAIRED BY THE CONTRACTOR AT NO COST TO THE CITY OF MUSKEGON. THE CITY OF MUSKEGON WILL PAY FOR RELOCATION OF IRRIGATION SYSTEMS DUE TO WIDENING OF ROAD OR IN CONFLICT WITH THE CONSTRUCTION OF UNDERGROUND WORK. PAYMENT WILL BE MADE BY A NEGOTIATED UNIT PRICE THROUGH A CONTRACT MODIFICATION. IT SHALL BE AT THE ENGINEER'S DISCRETION AS TO WHAT IRRIGATION REPAIR AND/OR RELOCATION IS THE RESULT OF CARELESS WORK BY THE CONTRACTOR OR THAT WHICH IS NECESSARY FOR THE CONSTRUCTION OF ROAD OR UTILITY WORK.
- 8. THE CONTRACTOR SHALL PREVENT EROSION AND CONTROL SEDIMENTATION ASSOCIATED WITH THE PROJECT. KEEP SEDIMENTATION WITHIN THE RIGHT OF WAY AND OUT OF SURFACE WATERS, CONSTRUCT AND MAINTAIN TEMPORARY EROSION AND SEDIMENTATION CONTROLS, CONTROLS TO INCLUDE EROSION CONTROL, INLET PROTECTION, FABRIC DROPS, ON ALL INLET STRUCTURES, NEW AND EXISTING, AND INSTALL TEMPORARY EROSION, SEDIMENTATION CONTROLS AS DIRECTED BY THE ENGINEER. THE CONTRACTOR SHALL REMOVE ON A DAILY BASIS SOIL TRACKED ONTO EXISTING PAVED ROADS, (VACUUM METHODS ARE PREFERRED BUT BROOM SWEEPING IS ACCEPTABLE IF THE MATERIAL IS REMOVED) THE CONTRACTOR SHALL INSPECT ALL SOIL EROSION/SEDIMENTATION CONTROL MEASURES ON A WEEKLY BASIS OR AFTER EACH RAIN FALL EVENT, CLEAN REPAIR, OR REPLACE, AS NECESSARY, TO ENSURE PROPER FUNCTION. ALL SOIL EROSION, SEDIMENTATION CONTROLS SHALL REMAIN UNTIL ALL DISTURBED AREAS ARE STABILIZED. ALL SOIL EROSION /SEDIMENTATION CONTROL, EXCEPT FOR THE EROSION CONTROL, INLET PROTECTION, FABRIC DROP, SHALL BE INCLUDED WITH THE PAY ITEM "PAVT, REM, MODIFIED" NO OTHER PAYMENT SHALL BE MADE.


CITY OF MUSKEGON OFFICE OF THE CITY ENGINEER **EMERALD** DRAWN F. PEASE FEB 19 REVISION

SURVEY F.PEASE NOV 15 H-91841 REVISION CHECKED APPROVED REVISION SCALE NO SCALESHEET NO 2 OF 4

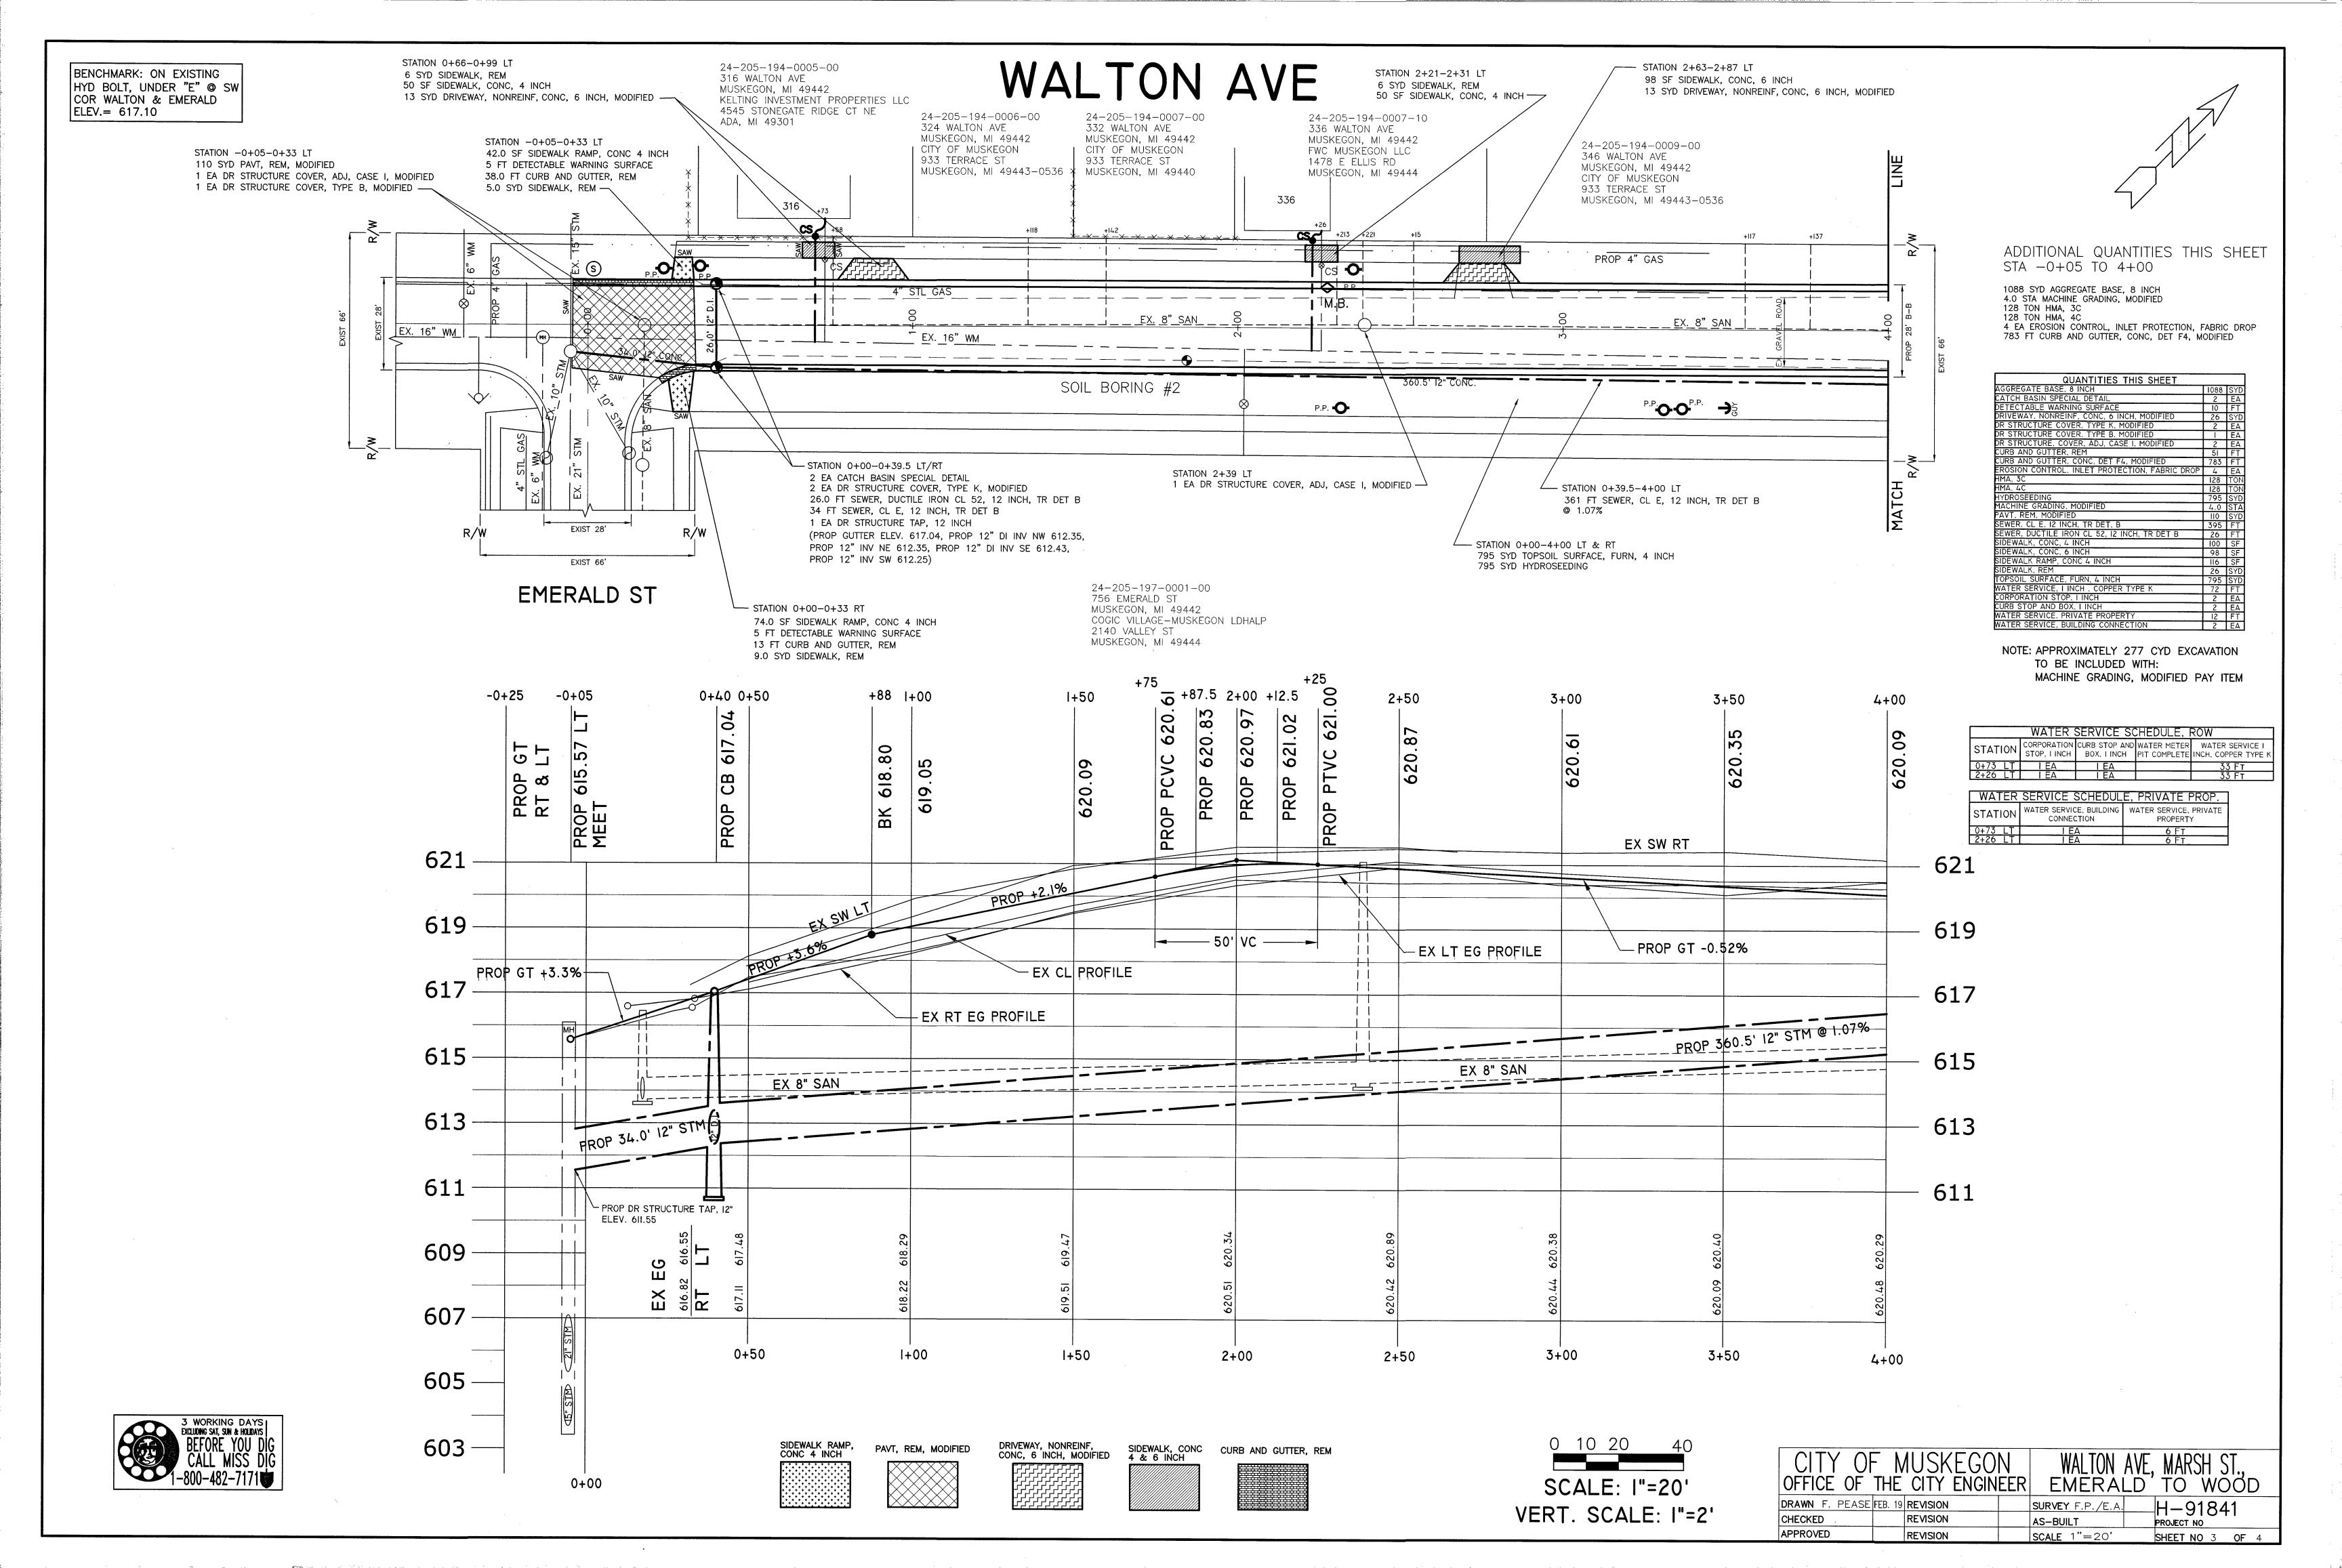


MARSH ST

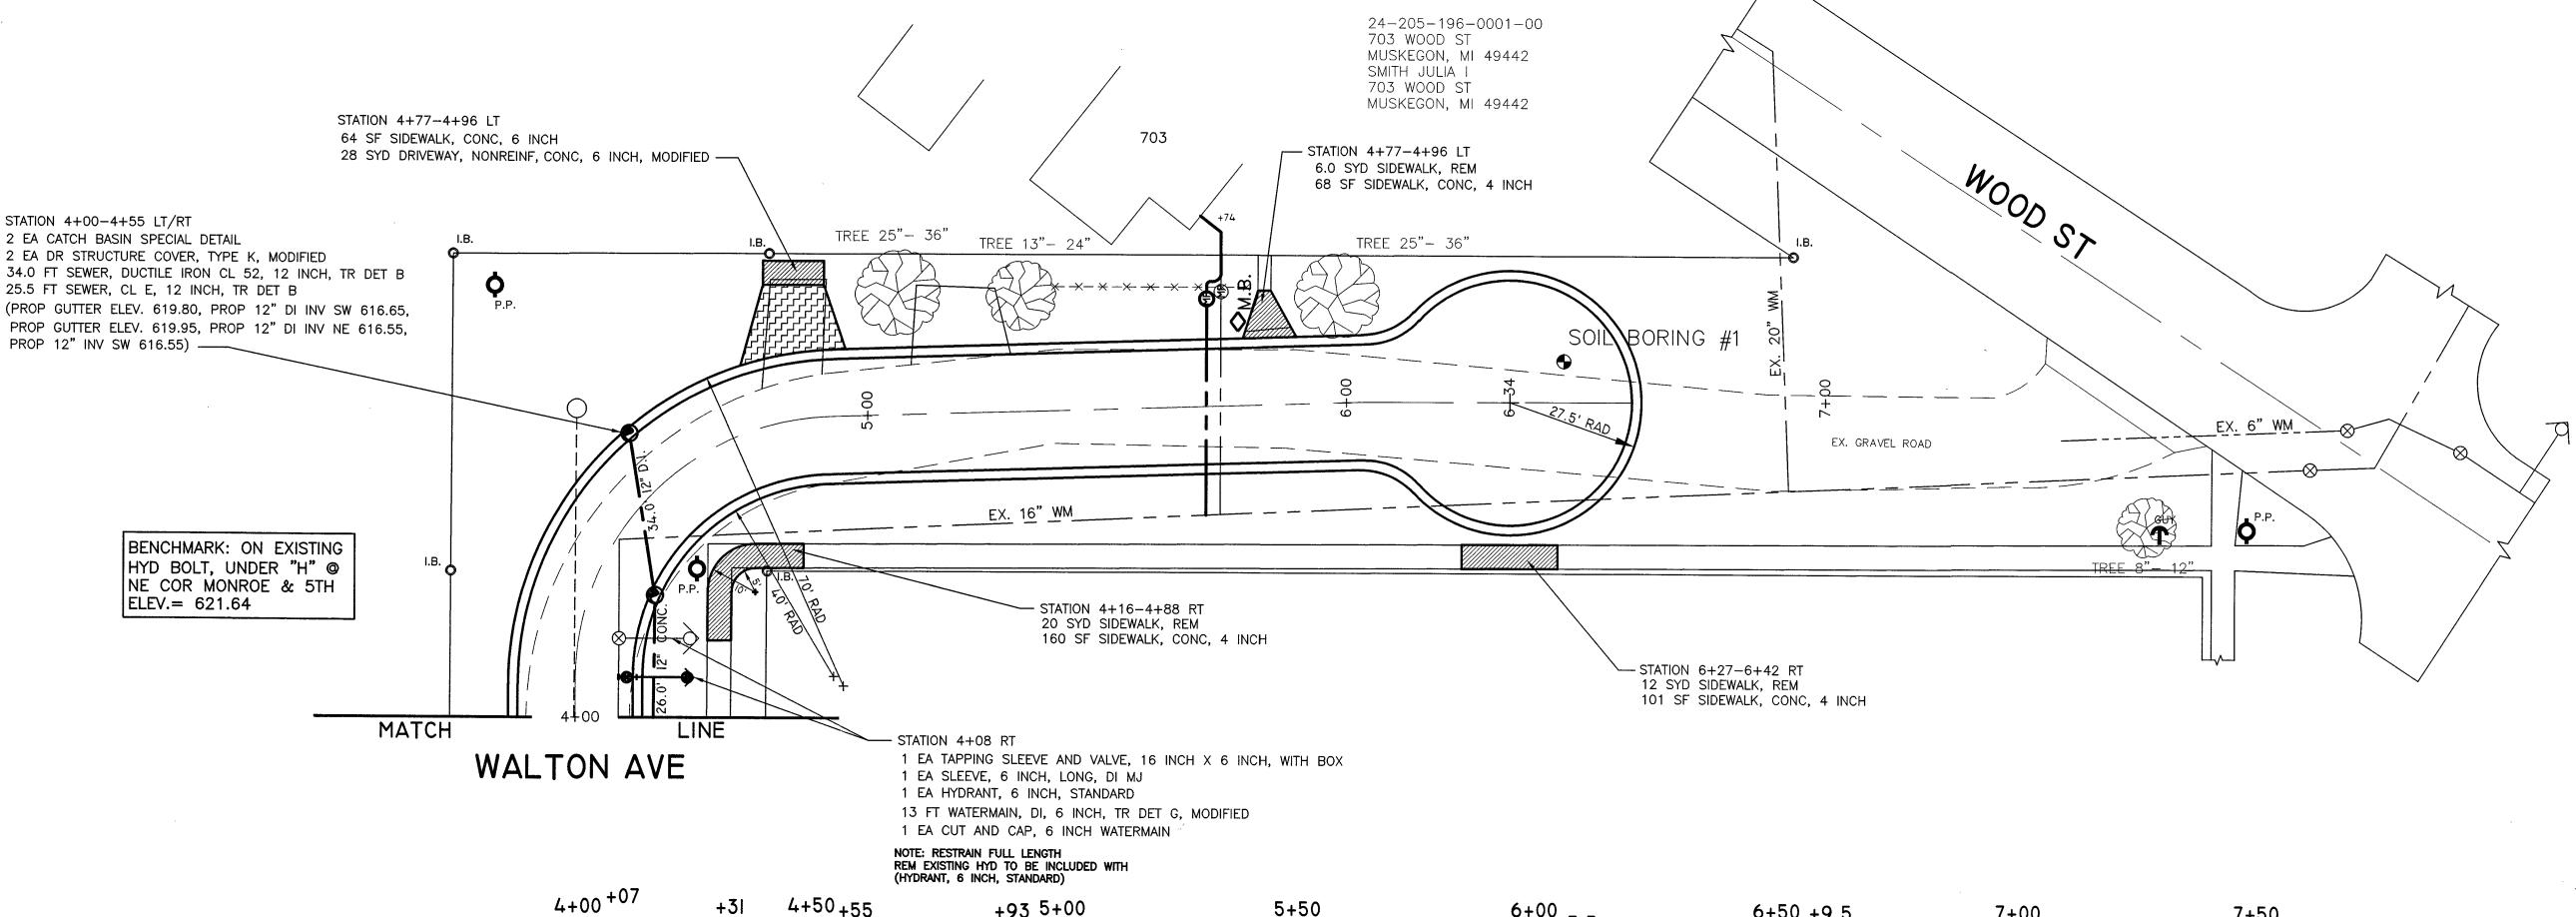

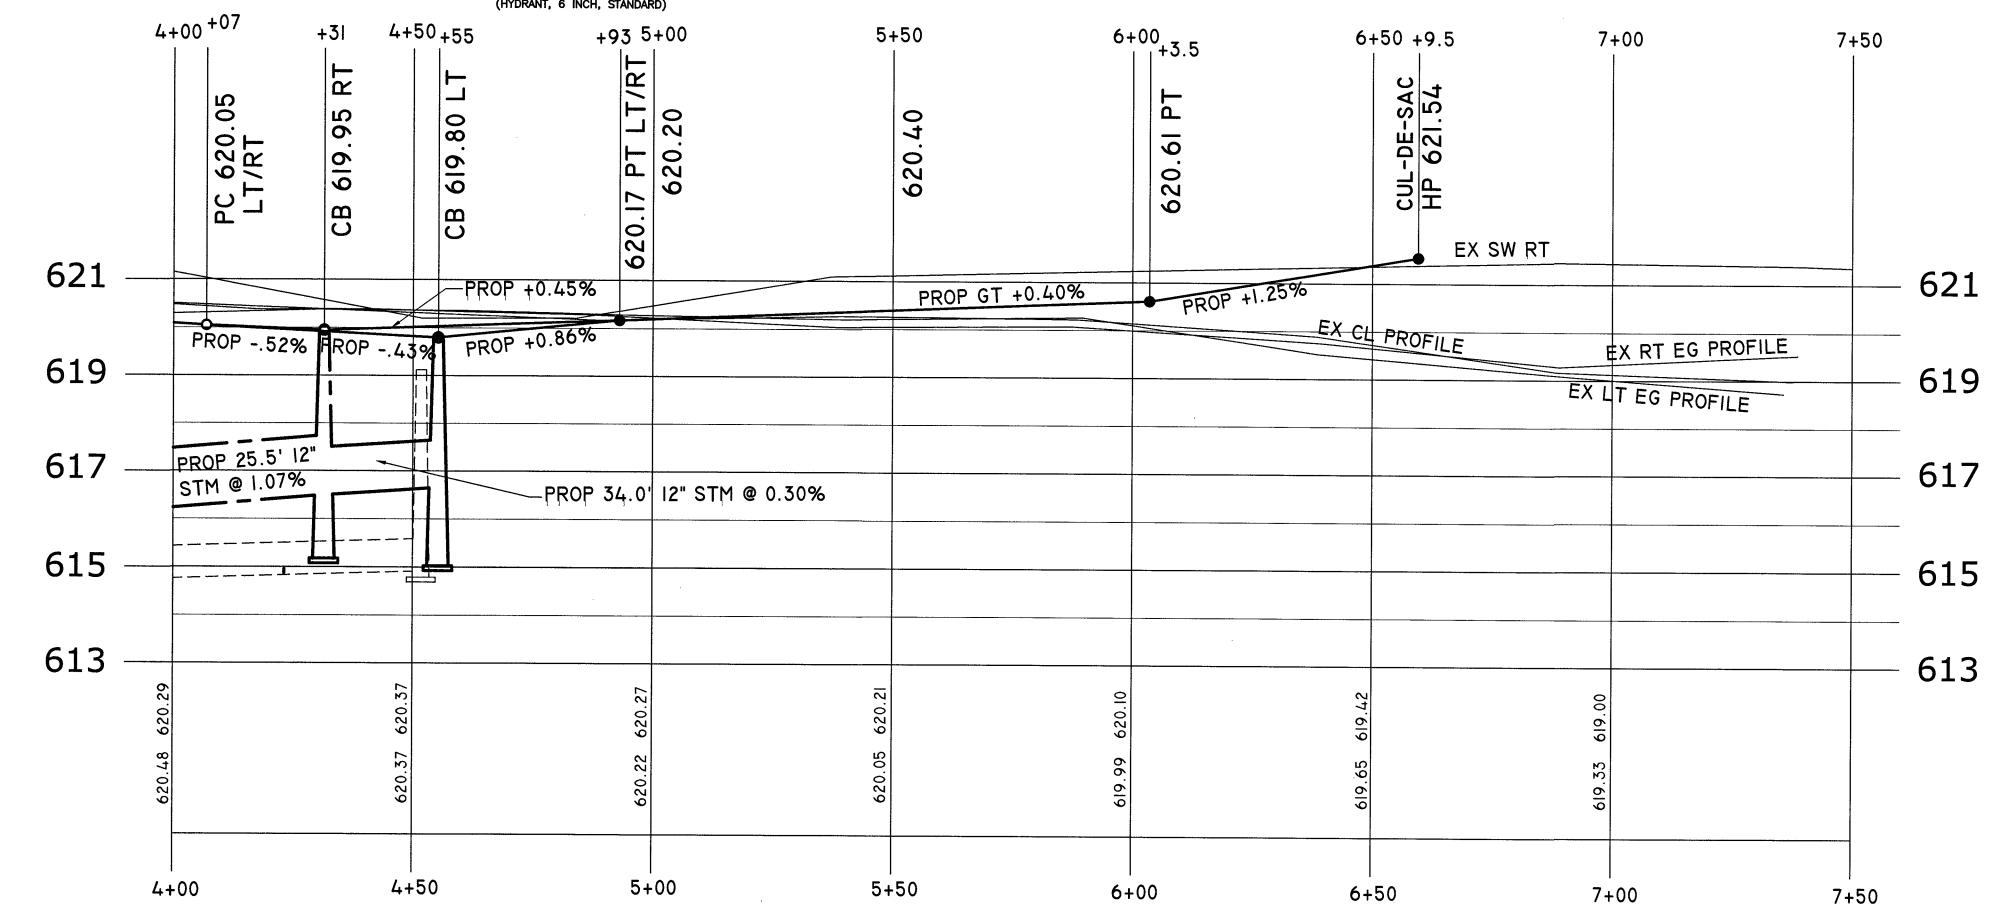

3 WORKING DAYS EXCUDING SAT, SUN & HOLDAYS DIG CALL MISS DIG 1-800-482-7171

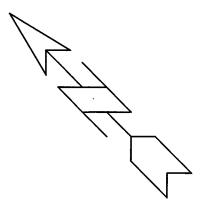

BENCHMARK: ON EXISTING HYD BOLT, UNDER "E" @ SE COR WOOD & WHITE ELEV.= 623.01

ADDITIONAL QUANTITIES THIS SHEET STA 4+00 TO 6+62

783 SYD AGGREGATE BASE, 8 INCH
2.6 STA MACHINE GRADING, MODIFIED
93 TON HMA, 3C
93 TON HMA, 4C

561 FT CURB AND GUTTER, CONC, DET F4, MODIFIED

QUANTITIES THIS SHEET		
AGGREGATE BASE, 8 INCH	783	SYL
CATCH BASIN SPECIAL DETAIL	2	EΑ
DRIVEWAY, NONREINF, CONC, 6 INCH, MODIFIED	28	SYL
DR STRUCTURE COVER, TYPE K, MODIFIED	2	EΑ
CURB AND GUTTER, CONC, DET F4, MODIFIED	561	FT
EROSION CONTROL, INLET PROTECTION, FABRIC DROP	2	EΔ
HMA, 3C	93	TO
HMA, 4Ĉ	93	TO
HYDRANT, 6 INCH STANDARD		EΔ
CUT AND CAP, 6 INCH WATERMAIN	-	EΔ
HYDROSEEDING	1088	SYI
MACHINE GRADING, MODIFIED	2.6	STA
SEWER, CL E, I2 INCH, TR DET, B	26	FT
SEWER, DUCTILE IRON CL 52. 12 INCH. TR DET B	34	FT
SIDEWALK, CONC, 4 INCH	329	
SIDEWALK, CONC. 6 INCH	64	SF
SIDEWALK, REM	38	SYI
TOPSOIL SURFACE, FURN, 4 INCH	1088	SYI
TAPPING SLEEVE AND VALVE, 16 INCH X 6 INCH WITH BOX		ЕΔ
WATERMAIN, DI, 6 INCH, TR DET G, MODIFIED	13	FT
SLEEVE, 6 INCH, LONG, DI MJ		EΑ
WATER SERVICE, I INCH, COPPER TYPE K	65	FT
CORPORATION STOP, I INCH		EΑ
METER PIT COMPLETE		EΑ
WATER SERVICE, PRIVATE PROPERTY	20	FT
WATER SERVICE, BUILDING CONNECTION		EΑ

NOTE: APPROXIMATELY 185 CYD EXCAVATION & 38.0 CUBIC YARDS OF EMBANKMENT TO BE INCLUDED WITH:

MACHINE GRADING, MODIFIED PAY ITEM

WATER SERVICE SCHEDULE, ROW								
STATION	CORPORATION STOP, I INCH	CURB STOP AND BOX, I INCH	WATER METER PIT COMPLETE	WATER SERVICE I INCH, COPPER TYPE				
5+74 LT	I EA		I EA	45 FT				

WATER SERVICE SCHEDULE, PRIVATE PROP.

STATION WATER SERVICE, BUILDING WATER SERVICE, PRIVATE PROPERTY

5+74 LT I EA 20 FT

CITY OF MUSKEGON
OFFICE OF THE CITY ENGINEER

EMERALD TO WOOD

DRAWN F. PEASE FEB. 19 REVISION
CHECKED
REVISION
SURVEY F.P. /E.A.
AS-BUILT
PROJECT NO
APPROVED
REVISION
SCALE 1"=20' SHEET NO 4 OF 4

0 10 20 40

SCALE: I"=20'

VERT. SCALE: I"=2'

DRIVEWAY, NONREINF, CONC, 6 INCH, MODIFIED 4 & 6 INCH